

ROLLER SHUTTER DOOR ------22.000 m GL 22.125 m

c:\bc-workspace\bolton_s\m-virtapp928s,d-high voltage\drawings\pe605 design services to aertech\027 - oriel windfarm 220 kv grid connection\pe605-d027-038-011-003.dwg


GIS HOIST AREA

22.150 m FFL


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Top of Parapet Roof Level Varies GIS SWITCHGEAR ROOM 26.150 m FFL _____V WC RELAY ROOM SECTION B-B SCALE 1:100 60675 Top of Parapet Roof Level Varies GIS SWITCHGEAR ROOM 26.150 m FFL _____V CABLE ROOM 22.150 m FFL 21.1<u>50</u> m 21.155 m <u>/</u> 21.150 m RADON SUMP DOOR OPENING SECTION C-C SCALE 1:100

60675

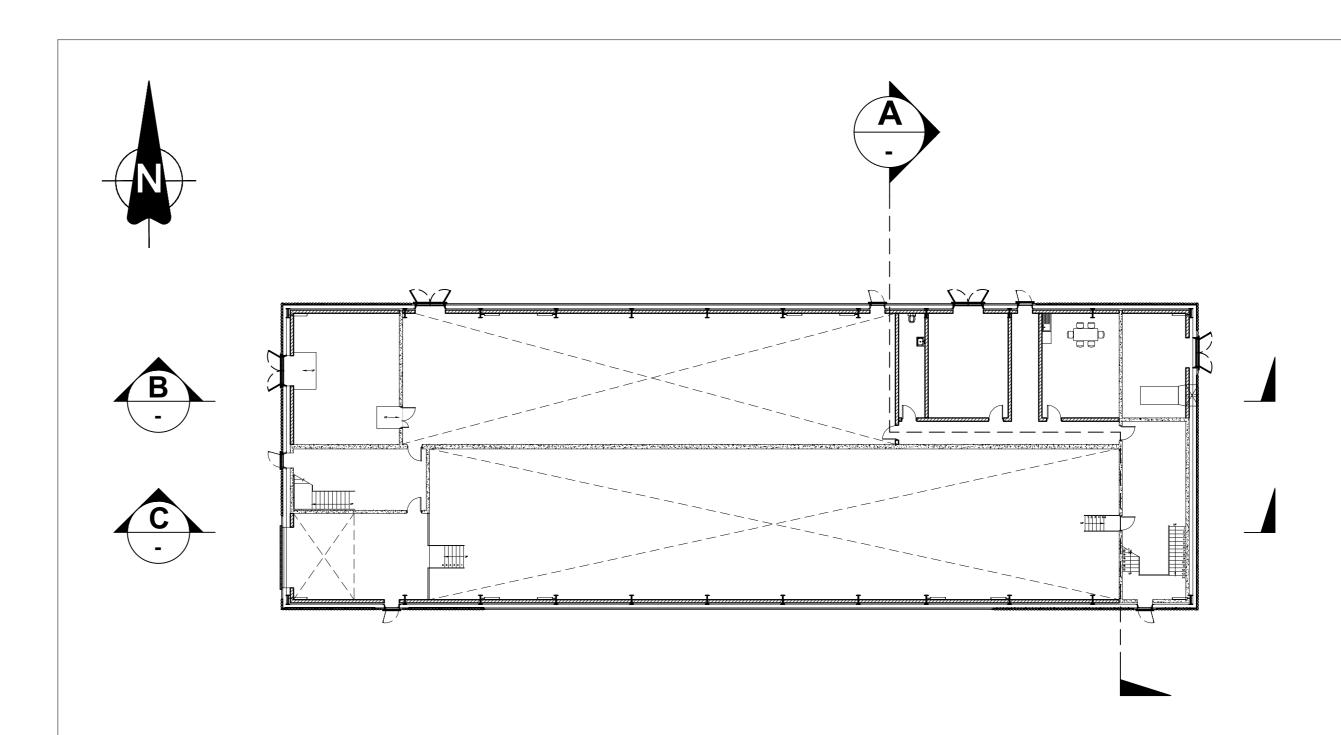

KEY PLAN OF GROUND FLOOR SCALE 1:250

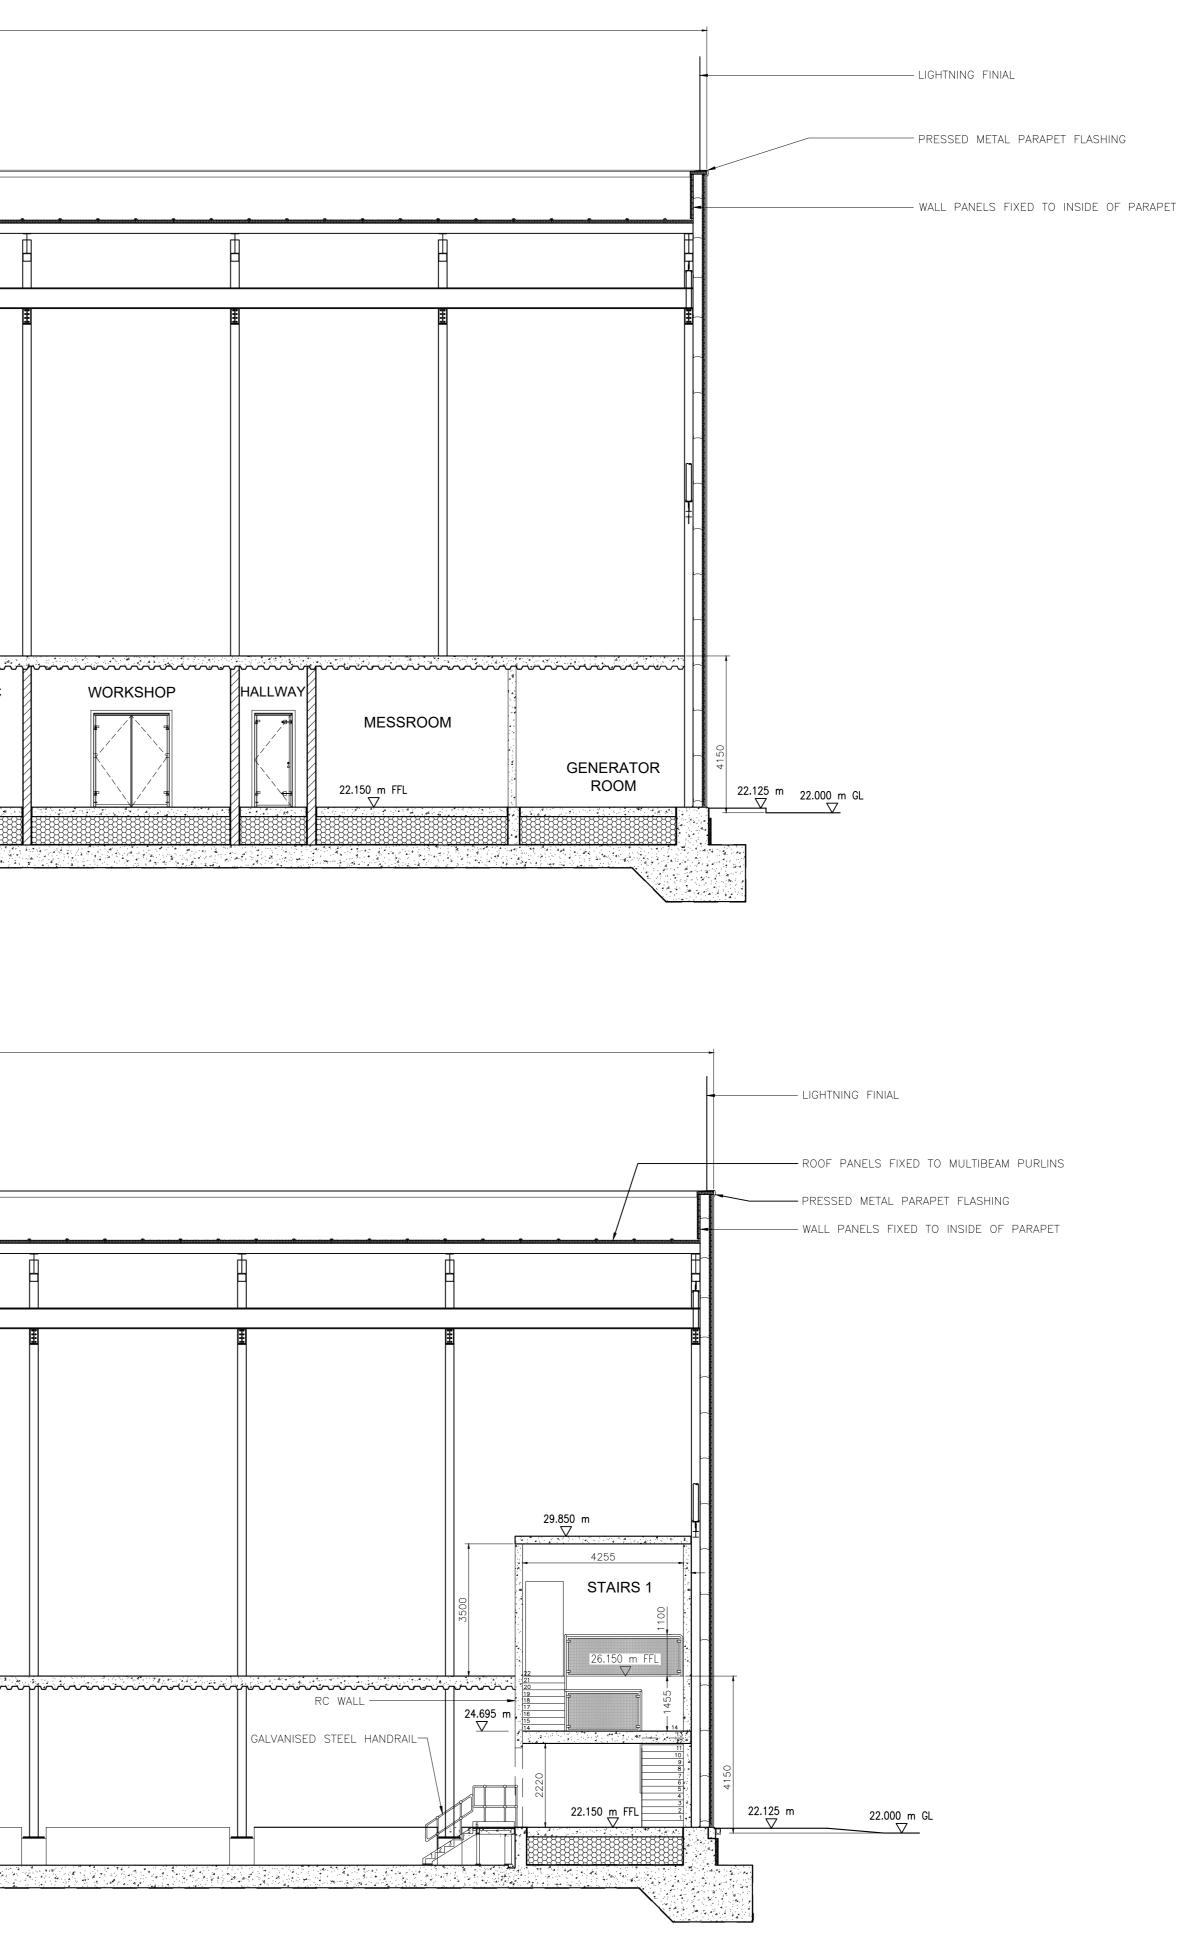

NOTES:

- 1. CO-ORDINATES TO ITM GRID.
- ALL DIMENSIONS ARE IN mm. NO DIMENSIONS SHALL BE SCALED FROM THE DRAWINGS.
- 3. THE BUILDING IS TO COMPLY WITH EIRGRID FUNCTIONAL SPECIFICATIONS
- 4. THIS DRAWING IS PRODUCED FOR PLANNING PURPOSES ONLY. ALL DIMENSIONS AND REFERENCES GIVEN ARE SUBJECT TO DETAILED DESIGN. THIS DRAWING IS NOT FOR CONSTRUCTION.
- CIVIL CALCULATIONS ARE TO BE CARRIED OUT AT THE DETAILED DESIGN STAGE AND TAKE INTO ACCOUNT SPECIFIC, EXISTING SITE GROUND CONDITIONS.
- 6. DIMENSIONS OF THE OVERALL BUILDING SHALL BE DESIGNED TO SUIT MANUFACTURER SPECIFIC DIMENSIONS. ENVELOPE AROUND THE SWITCHGEAR SHALL BE WITH MANUFACTURER RECOMMENDATIONS FOR ON-GOING OPERATION, MAINTENANCE AND REPLACEMENT OF HV PI ANT
- 7. SPECIFIC SWITCHGEAR ROOM REQUIREMENTS ARE TO SUIT THE MANUFACTURER'S SPECIFICATIONS AND TO BE EVALUATED AT THE DETAILED DESIGN STAGE.
- 8. WALL AND ROOF PANELS TO BE INSULATED AND METAL FACED, CORNER FLASHING TO BE PLASTISOL COATED PRESSED METAL, PARAPET AND DRIP FLASHINGS TO BE PRESSED METAL, DOORS, DOOR FRAMES, VENTS AND VENT FRAMES TO BE GALVANISED STEEL.
- 9. THE FINISHED EXTERNAL BUILDING SURFACE COLOURS ARE TO BE COLOUR RAL 6006 OR SIMILAR.
- 10. ALL DUCTS ARE INDICATIVE DETAIL.
- 11. REFER TO THE LATEST REVISONS OF THE FOLLOWING DRAWINGS FOR FURTHER DETAIL: a. PE605-D027-038-009 FOR GIS BUILDING GROUND AND FIRST FLOOR PLANS b. PE605-D027-038-010 FOR GIS BUILDING ELEVATIONS c. PE605-D027-038-026 FOR GIS BUILDING ROOF PLAN.

3		PROJECT TITLE REVISED	SB			
2	21.08.23	GENERATOR ROOM DOOR MOVED	SB	SB	SD	JMcL
1	06/05/22	CABLE DUCT DETAIL ADDED TO SECTION A. NOTES ADDED ALL DIMENSION, LEVEL AND TEXT DETAILS UPDATED.	SB	RH	SD	SS
0	17/12/20	INITIAL VERSION	RK	RH	BP	SK
REV	DATE	REVISION DESCRIPTION	DRN	PROD	VER	APP
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PURPOSE OF ISSUE - PRELIMINARY UNLESS INDICATED						
CLIENT Oriel Windfarm Limited						
Oriel Wind Farm Project						
CONTRACT						
ONSHORE SUBSTATION COMPOUND 1 GIS BUILDING SECTIONS						
PRODUCTION UNIT Civil, Environmental and Renewable Engineering						
Energy for generations Engineering and Major Projects, One Dublin Airport Central, Dublin Airport, Cloghran, Co. Dublin, K67 XF72, Ireland. Tel: +353 (0)1 703 8000 Web: www.esb.ie Engineering and Major Projects is a division of ESB.						
DRA		PRODUCED VERIFIED APPROVED	- 11			
	S.Bolton	S.Bolton S. Donnelly J.McLougl NO. OF SHTS SIZE	חוור	21 SCAL	/02/20 E	24
		TC223815 1 A0			1:100	
DRAWING NUMBER SHEET REV PE605-D027-038-011-003						